




1 ABUTMENT ELEVATION
SCALE 1:50

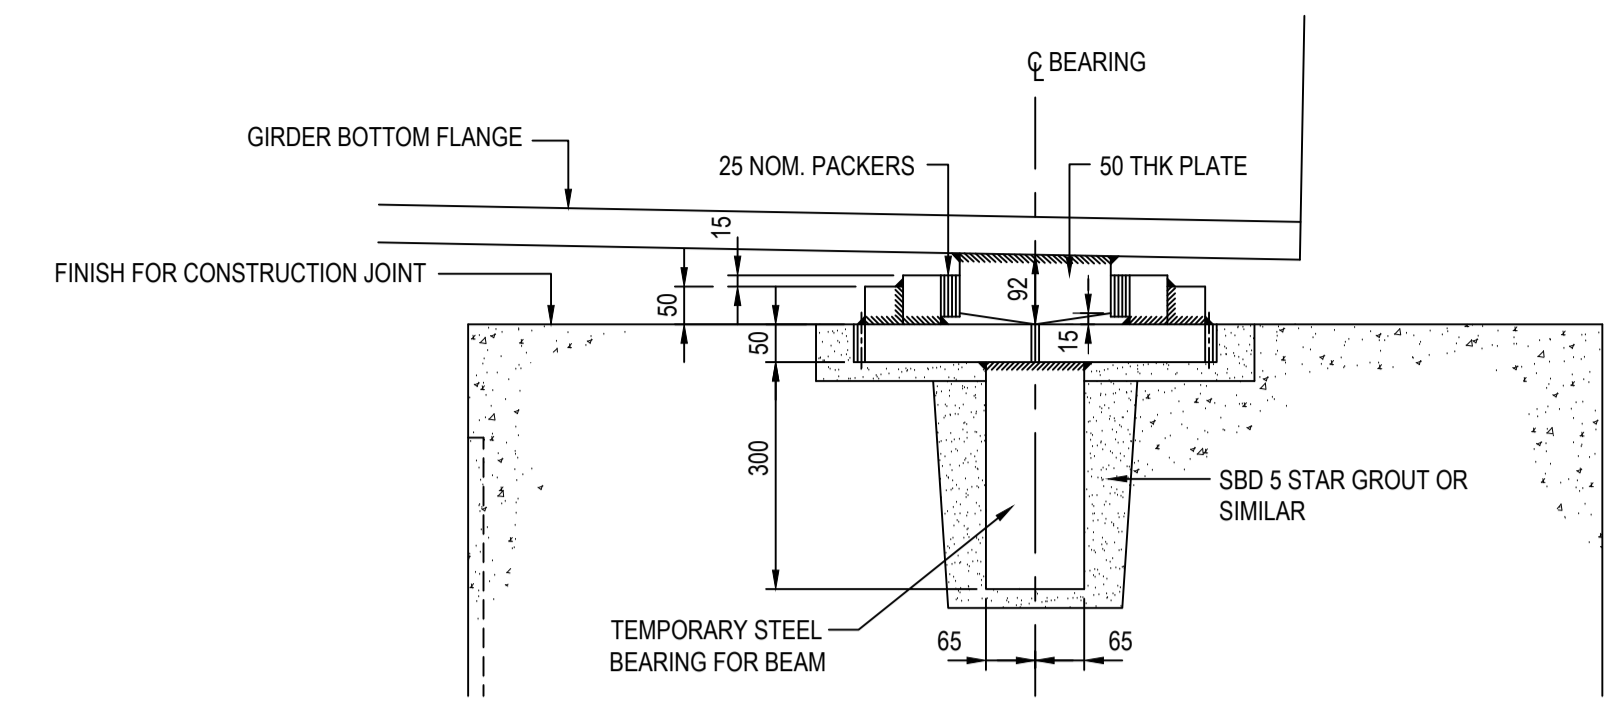


1 DETAIL OF TEMPORARY BEAM SUPPORT
SCALE 1:10

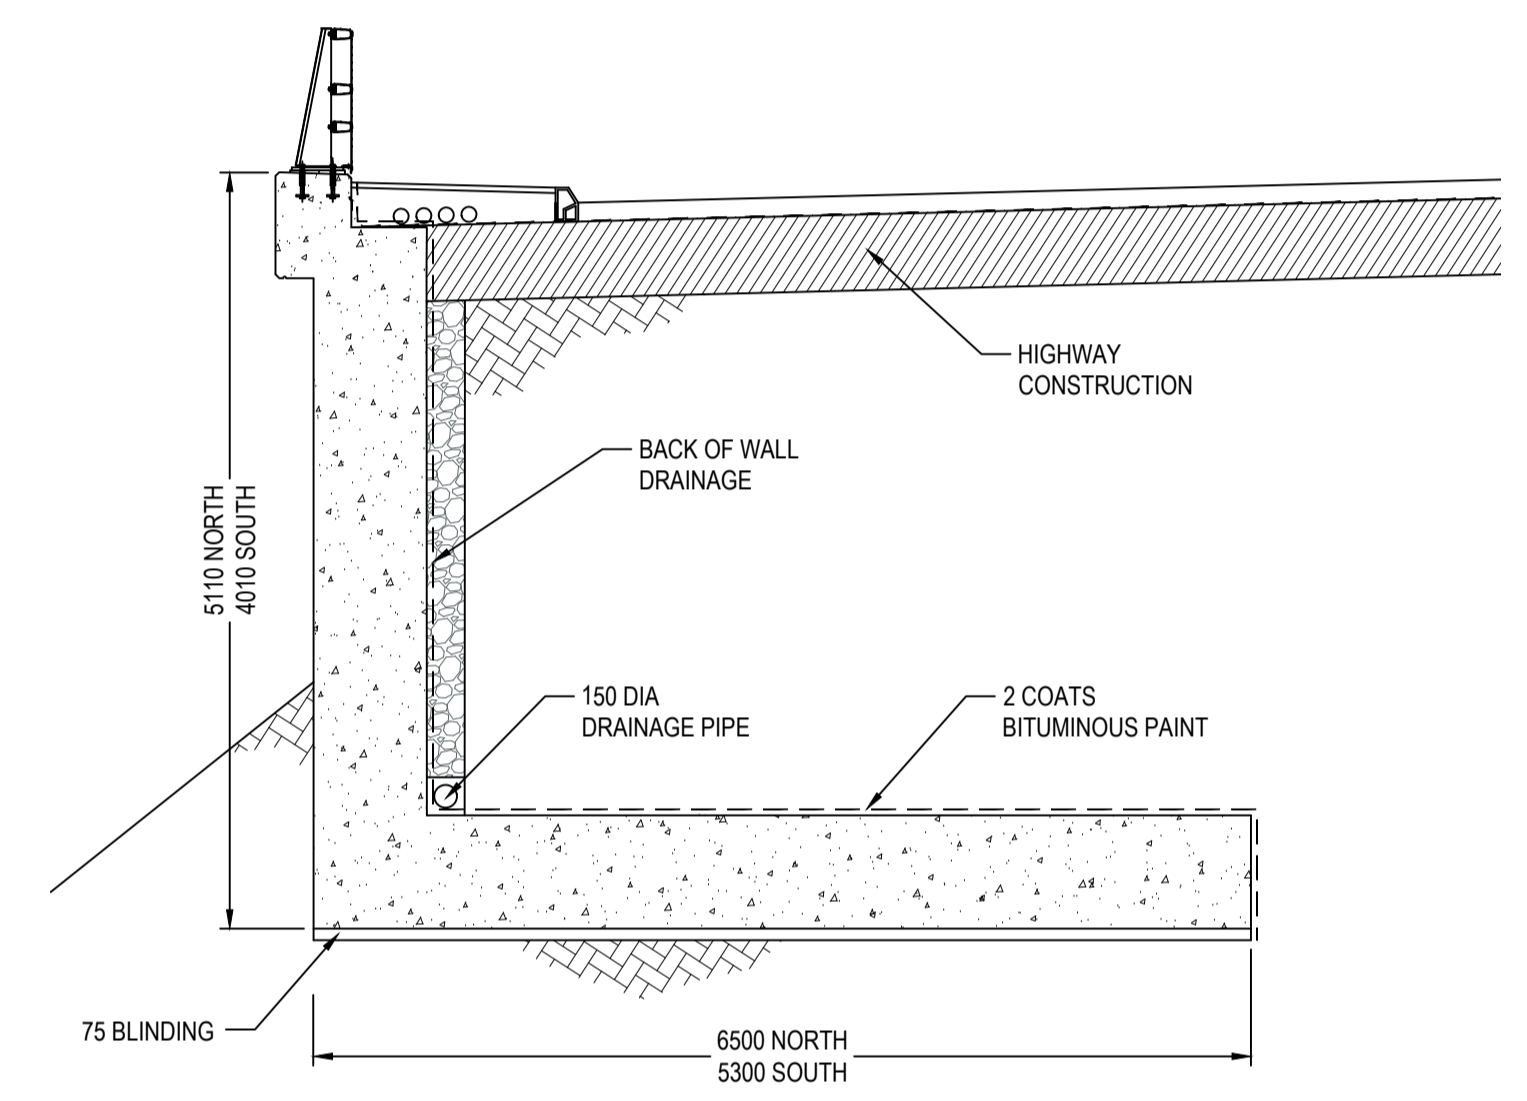


TYPICAL WINGWALL SECTION
SCALE 1:50

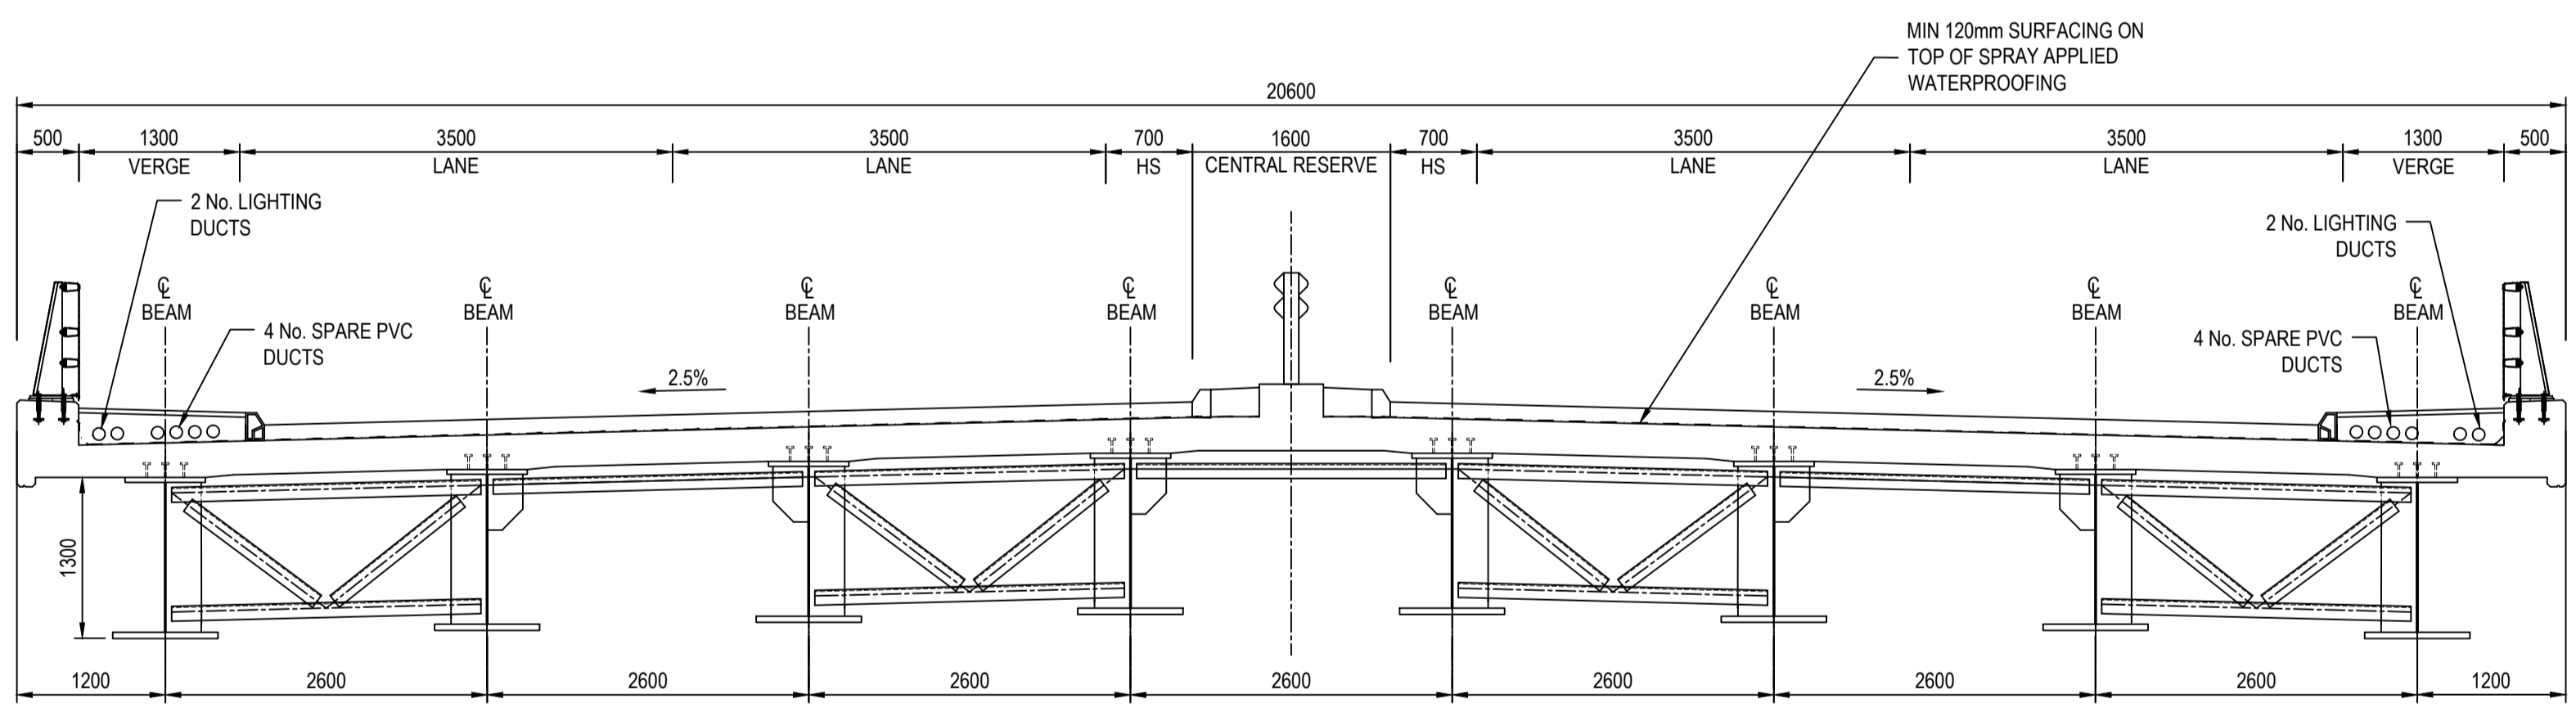

SECTION AT MID-SPAN
SCALE 1:50

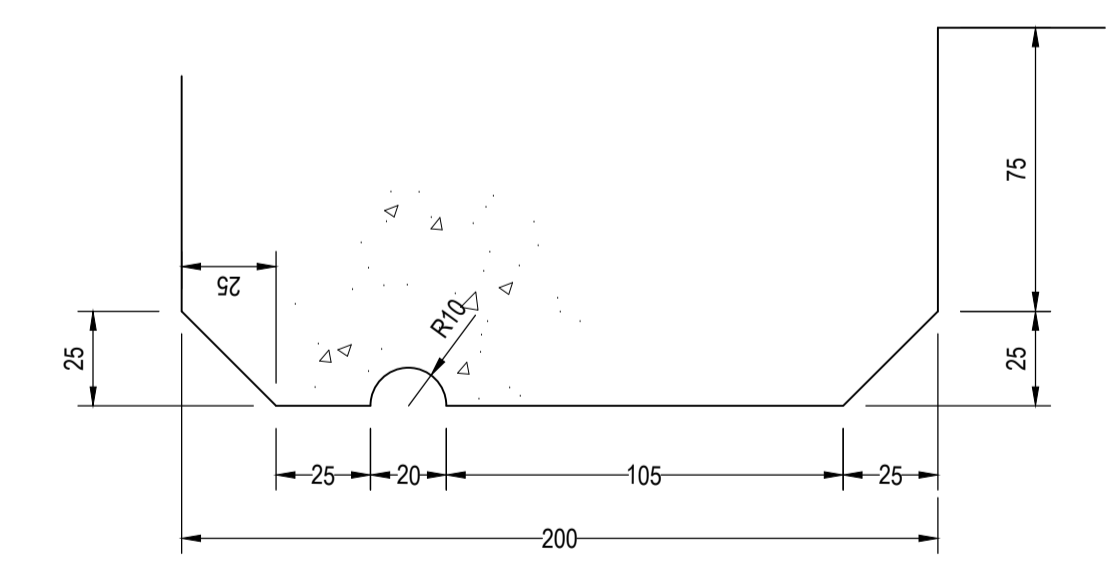

2 DRIP DETAIL
SCALE 1:2

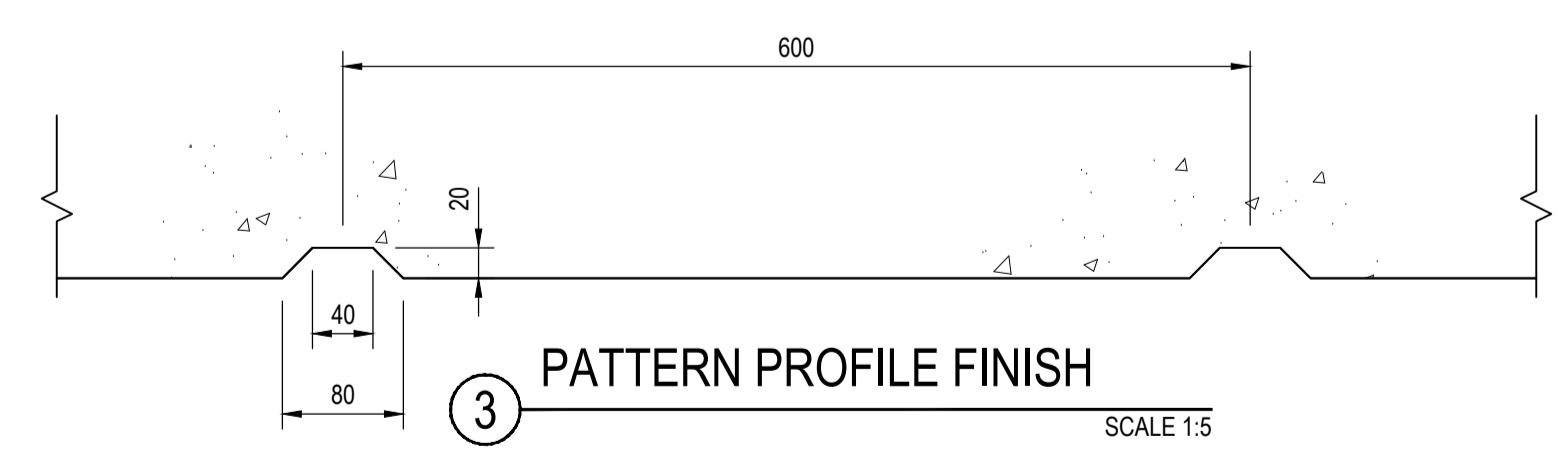

3 PATTERN PROFILE FINISH
SCALE 1:5

- All dimensions are in millimetres, all levels, chainages and co-ordinates are in metres unless otherwise stated.
- All levels are in meters above Ordnance Datum.
- Structural steel shall be grade S355J2W + N weathering steel to BS EN 10025-5: 2004.
- Structural concrete grades shall be as follows:
Deck slab and diaphragm: MIX 1 C40/50.
Parapet string course: MIX 2 C40/50.
Abutment pile cap and wingwalls: MIX 3 C40/50.
Piles: MIX 6 C32/40.
- Reinforcement shall conform to BS EN 10080 AND BS EN 449 Grades B500B and B550C.

Client

DELIVERING THROUGH

Project SMART MOTORWAYS PROGRAMME
M4 JUNCTIONS 3-12

Drawing title
HUNTERCOMBE SPUR
REPLACEMENT OVERBRIDGE
GENERAL ARRANGEMENT
REGULATION 4(2)(e) SHEET 2 OF 2

Status	S2	Revision	P01
Scale	AS SHOWN @ A1	Date	18/02/2022
Drawn By	W. Emery		
Checked By	P. Kemm		
Approved By	D. Pilsworth		
Project No.	HA PIN HA514451	Originator	CHHJ
Drawing number	Volume Location SBR-S2_BR00033592-DR-CB-1411	Type Role Number	A1

P01	S4	18/02/2022	Non-Material Change Application	WE	PK	DP
Rev	Status	Rev. Date	Purpose of revision	Drawn	Chk'd	Appr'd